



PUBLIC NOTICE

**US Army Corps
Of Engineers**
Wilmington District

Issue Date: June 27, 2024
Comment Deadline: July 29, 2024
Corps Action ID Number: SAW-2008-02370

The Wilmington District, Corps of Engineers (Corps) received an application on June 13, 2024 from Republic Services (Republic) seeking Department of the Army authorization to discharge fill material into 0.69-acre of wetlands and 1,527 linear feet of stream associated with the Phase 6 expansion of the existing White Oak Landfill in Waynesville, Haywood County, North Carolina.

Specific plans and location information are described below and shown on the attached plans. This Public Notice and all attached plans are also available on the Wilmington District Web Site at:

<https://www.saw.usace.army.mil/Missions/Regulatory-Permit-Program/Public-Notices/>

Applicant: Stoddard Pickrell
Republic Services
1070 Riverside Drive
Asheville, North Carolina 28804

AGENT (if applicable): Lisa Mash
Civil & Environmental Consultants, LLC
777 Lowndes Hill Road, Bldg. 2, Suite 100
Greenville, South Carolina 29607

Authority

The Corps evaluates this application and decides whether to issue, conditionally issue, or deny the proposed work pursuant to applicable procedures of the following Statutory Authorities:

- Section 404 of the Clean Water Act (33 U.S.C. 1344)
- Section 10 of the Rivers and Harbors Act of 1899 (33 U.S.C. 403)
- Section 103 of the Marine Protection, Research and Sanctuaries Act of 1972 (33 U.S.C. 1413)

Location

Location Description: The proposed project is located within the existing White Oak Landfill property at a physical address of 3898 Fines Creek Road, Waynesville, North Carolina. This facility is located to the south of Interstate 40 and west of Fines Creek Road in Haywood County, along the south side of the Pigeon River.

Project Area (acres): Approximately 16.2 acres
Nearest Town: Waynesville
Nearest Waterway: Pigeon River
River Basin: Pigeon River
Latitude and Longitude: 35.663143 N, -83.004200 W

Existing Site Conditions

The project area is fully encompassed within an approximate 268.7-acre property owned by Haywood County, North Carolina. Currently, the White Oak Landfill, an active non-hazardous, municipal solid waste, and construction and demolition debris landfill, occupies approximately 75.1 acres of the larger property (Figure 1). The specific project area is identified as the proposed Phase 6 Expansion Area (Figure 2) and consists of roughly 16.2 acres of undeveloped forested land that is immediately adjacent to the south of the existing landfilling operations. Four wetlands (Wetlands WA1 through WA4) totaling 1.114 acres and four streams (Streams SA1, SA2, SA7, and SA8) totaling 2,722 linear feet are located within the project area.

Proposed Project Description

The White Oak Landfill is an existing solid waste disposal facility that is owned by Haywood County, North Carolina and operated by Republic in cooperation with Santek Environmental of North Carolina, LLC. This facility was originally permitted on July 22, 1992, and began receiving waste on October 8, 1993. In accordance with North Carolina General Statutes 130A-294(a2), the permit (44-07) is for the "life-of-site of the facility" which is defined as the period from the initial receipt of solid waste at the facility until the facility reaches its final permitted elevations, which shall not exceed 60 years. Therefore, the permit shall expire on October 8, 2053.

The existing facility encompasses approximately 268.7 acres, of which the total permitted area for landfill disposal is 75.1 acres (Figure 2). The remaining areas (193.6 acres) are utilized for supporting infrastructure, soil borrow areas, or remain undisturbed. The 75.1-acre permitted landfill disposal boundary has been broken down into Phases 1 through 7 for construction and waste filling. Each phase is permitted and constructed as the need for additional airspace (available volume of permitted space) arises. The facility is currently permitted to accept approximately 146,000 tons of non-hazardous solid waste per year from a service area that includes 18 counties (Avery, Buncombe, Burke, Cherokee, Clay, Graham, Haywood, Henderson, Jackson,

Macon, Madison, McDowell, Mitchell, Polk, Rutherford, Swain, Transylvania, and Yancey) in western North Carolina.

At this time, approximately 44.6 acres have been constructed and are accepting waste (Phases 1 through 5). At the current acceptance rate, this existing area is expected to provide approximately two more years of disposal capacity. Therefore, Republic is proposing to increase the White Oak Landfill's current disposal capacity through lateral operational expansion into the Phase 6 area within the permitted 75.1-acre boundary. The proposed Phase 6 expansion area is roughly 16.2 acres in size and would provide approximately 3,000,000 cubic yards (CY) of additional airspace to extend the life of this facility for an additional 12 years. The gain in airspace would be achieved by excavating 900,000 CY of native materials and placing 155,000 CY of structural fill to accept the additional waste. Underdrain piping will be installed to continue carrying baseflow of Stream SA1 under the filled area. A bypass channel will be constructed to divert upstream flow from Stream SA1 around the structural fill embankment. The proposed lateral expansion into the Phase 6 area would cause a permanent loss of 0.69-acre of wetlands and 1,527 linear feet of stream.

Applicant's Stated Purpose

The purpose of the proposed expansion is to improve the landfill's current disposal capacity by increasing the landfill's airspace. Landfill airspace is the design volume of space measured in cubic yards available for disposal. Optimization takes into consideration the land available for development, including the various facilities and systems necessary for the landfill's operations. The type of design, depth of landfill, base slopes, leachate collection pipe slope, perimeter berm geometry and size, slopes of landfill side slopes, terraces on slopes, and many other parameters determine the airspace volume available to the landfill operator.

Given the current waste acceptance rate, the White Oak Landfill's previously constructed landfill phases (Phases 1-5) are nearing completion and are expected to reach capacity within two years. The proposed expansion for Phase 6 would provide approximately 3,000,000 CY of additional airspace for waste disposal to allow for an additional 12 years of disposal capacity. The proposed landfill expansion is needed to support waste generated by the 18 counties in western North Carolina (i.e., the service area).

Avoidance and Minimization

The applicant provided the following to document efforts to avoid and/or minimize impacts to the aquatic environment:

Per the applicant, as part of the Alternatives Analysis, Republic has avoided and minimized impacts to waters of the U.S. to the greatest extent practicable. The project was designed to avoid impacts to approximately 0.424-acre of wetlands and 1,195 linear feet of stream channels. With unavoidable impacts to waters of the U.S. from the

proposed project at the existing White Oak Landfill, Republic understands that compensatory mitigation of waters of the U.S. may be required for lost functions and values of the wetlands and streams at the site.

Compensatory Mitigation

The applicant offered the following compensatory mitigation proposal to offset unavoidable functional loss to the aquatic environment:

The applicant proposes to mitigate for the loss of 0.69-acre of wetlands and 1,527 linear feet of stream by requesting the consideration of two mitigation options, as follows: 1) Development of a Turnkey-Mitigation Permittee Responsible Mitigation Site; or 2) Purchase of advanced credits through the North Carolina Department of Environmental Quality (NCDEQ) - Division of Mitigation Services (DMS) In-lieu Fee (ILF) Program.

Cultural Resources

Pursuant to Section 106 of the National Historic Preservation Act of 1966, Appendix C of 33 CFR Part 325, and the 2005 Revised Interim Guidance for Implementing Appendix C, the District Engineer consulted district files and records and the latest published version of the National Register of Historic Places and initially determines that:

- The Corps has determined the undertaking consists of the issuance of a permit to discharge fill material into waters of the U.S. for the purposes of expansion of an existing landfill facility. The Corps determined the permit area to be the same as the Applicant's project area. The permit area has been previously surveyed, and no historic properties eligible for inclusion on the National Register of Historic Places have been identified. Therefore, the Corps determined the proposed project would have **no effect** on historic properties and subsequently requests concurrence from the SHPO and/or THPO.

Endangered Species

Pursuant to the Endangered Species Act of 1973, the Corps reviewed the project area, examined all information provided by the applicant and consulted the latest North Carolina Natural Heritage Database. Based on available information:

- The Corps has performed an initial review of the application, the U.S. Fish and Wildlife Service (USFWS) Information for Planning and Consultation to determine if any threatened, endangered, proposed, or candidate species, as well as the proposed and final designated critical habitat may occur within the boundary of the proposed project. Based on the initial review, the Corps determined the project may affect, but not adversely affect federally listed species. Pursuant to Section 7 ESA, the required consultation with the USFWS will be conducted in accordance with 50 CFR part 402 under separate cover.

Other Required Authorizations

The Corps forwards this notice and all applicable application materials to the appropriate State agencies for review.

North Carolina Division of Water Resources (NCDWR):

- The Corps will generally not make a final permit decision until the NCDWR issues, denies, or waives the state Certification as required by Section 401 of the Clean Water Act (PL 92-500). The receipt of the application and this public notice at the NCDWR Central Office in Raleigh constitutes initial receipt of an application for a 401 Certification. Unless NCDWR is granted a time review extension, a waiver will be deemed to occur if the NCDWR fails to act on this request for certification within 180 days of the date of this public notice. Additional information regarding the 401 Certification may be reviewed at the NCDWR Central Office, 401 and Buffer Permitting Unit, 512 North Salisbury Street, Raleigh, North Carolina 27604-2260. All persons desiring to make comments should do so in writing, within 30 days of the issue date of the notice by emailing comments to publiccomments@deq.nc.gov with the subject line of "401 Water Quality Certification" or by mail to:

NCDWR Central Office
Attention: Stephanie Goss, 401 and Buffer Permitting Branch
1617 Mail Service Center, Raleigh, NC 27699-1617

Or,

(physical address): 512 North Salisbury Street, Raleigh, North Carolina
27604

Evaluation

The decision whether to issue a permit will be based on an evaluation of the probable impacts including cumulative impacts of the proposed activity on the public interest. That decision will reflect the national concern for both protection and utilization of important resources. The benefit which reasonably may be expected to accrue from the proposal must be balanced against its reasonably foreseeable detriments. All factors which may be relevant to the proposal will be considered including the cumulative effects thereof; among those are conservation, economics, aesthetics, general environmental concerns, wetlands, historic properties, fish and wildlife values, flood hazards, flood plain values (in accordance with Executive Order 11988), land use, navigation, shoreline erosion and accretion, recreation, water supply and conservation, water quality, energy needs, safety, food and fiber production, mineral needs, considerations of property ownership, and, in general, the needs and welfare of the people. For activities involving the discharge of dredged or fill materials in waters of the

United States, the evaluation of the impact of the activity on the public interest will include application of the Environmental Protection Agency's 404(b)(1) guidelines.

Commenting Information

The Corps of Engineers is soliciting comments from the public; Federal, State, and local agencies and officials, including any consolidated State Viewpoint or written position of the Governor; Indian Tribes and other interested parties in order to consider and evaluate the impacts of this proposed activity. Any comments received will be considered by the Corps of Engineers to determine whether to issue, modify, condition, or deny a permit for this proposal. To make this decision, comments are used to assess impacts on endangered species, historic properties, water quality, general environmental effects and the other public interest factors listed above. Comments are used in the preparation of an Environmental Assessment (EA) and/or an Environmental Impact Statement (EIS) pursuant to the National Environmental Policy Act (NEPA). Comments are also used to determine the need for a public hearing and to determine the overall public interest of the proposed activity.

Any person may request, in writing, within the comment period specified in this notice, that a public hearing be held to consider the application. Requests for public hearings shall state, with particularity, the reasons for holding a public hearing. Requests for a public hearing will be granted, unless the District Engineer determines that the issues raised are insubstantial or there is otherwise no valid interest to be served by a hearing.

The Corps of Engineers, Wilmington District will receive written comments pertinent to the proposed work, as outlined above, until 5pm, July 29, 2024. Comments should be submitted to Ms. Brooke Davis, Asheville Regulatory Field Office, 151 Patton Avenue, Room 208, Asheville, North Carolina 28801-5006, or via email at brooke.a.davis@usace.army.mil. The Corps Project Manager can be contacted at (828) 271-7980 ext. 4232. Comments may also be submitted to AshevilleNCREG@usace.army.mil.





REFERENCE(S):

- 1. USGS TOPOGRAPHIC MAP / ARCGIS MAP SERVICE:
 ACCESSED 6/11/2024.
 COVE CREEK GAP, NORTH CAROLINA QUADRANGLE
 PUBLISHED 1979.

LANDFILL DISPOSAL BOUNDARY
 (35.35.663087, -83.005442)

LEGEND

- PERMITTED LANDFILL DISPOSAL BOUNDARY
- LANDFILL FACILITY BOUNDARY

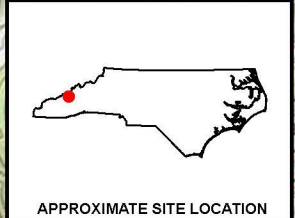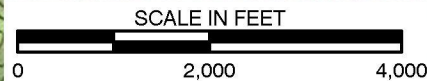

**Civil & Environmental
 Consultants, Inc.**

3701 Arco Corporate Drive
 Suite 400
 Charlotte, NC 28273
 Ph: 980.237.0373 · 855.859.9932
 www.cecinc.com


REPUBLIC SERVICES, INC.
WHITE OAK LANDFILL
HAYWOOD COUNTY, NORTH CAROLINA

SITE LOCATION MAP

DRAWN BY:	NTP	CHECKED BY:	LRM	APPROVED BY:	LRM*	FIGURE NO:	1
DATE:	05/31/2024	SCALE:	1"=2,000'	PROJECT NO:	331-924		


*Hand Signature on file

REFERENCES
 1. ESRI WORLD IMAGERY / ARCGIS MAP SERVICE:
 HTTP://GOTO.ARCGISONLINE.COM/MAPS/WORLD_IMAGERY,
 ACCESSED 5/30/2024

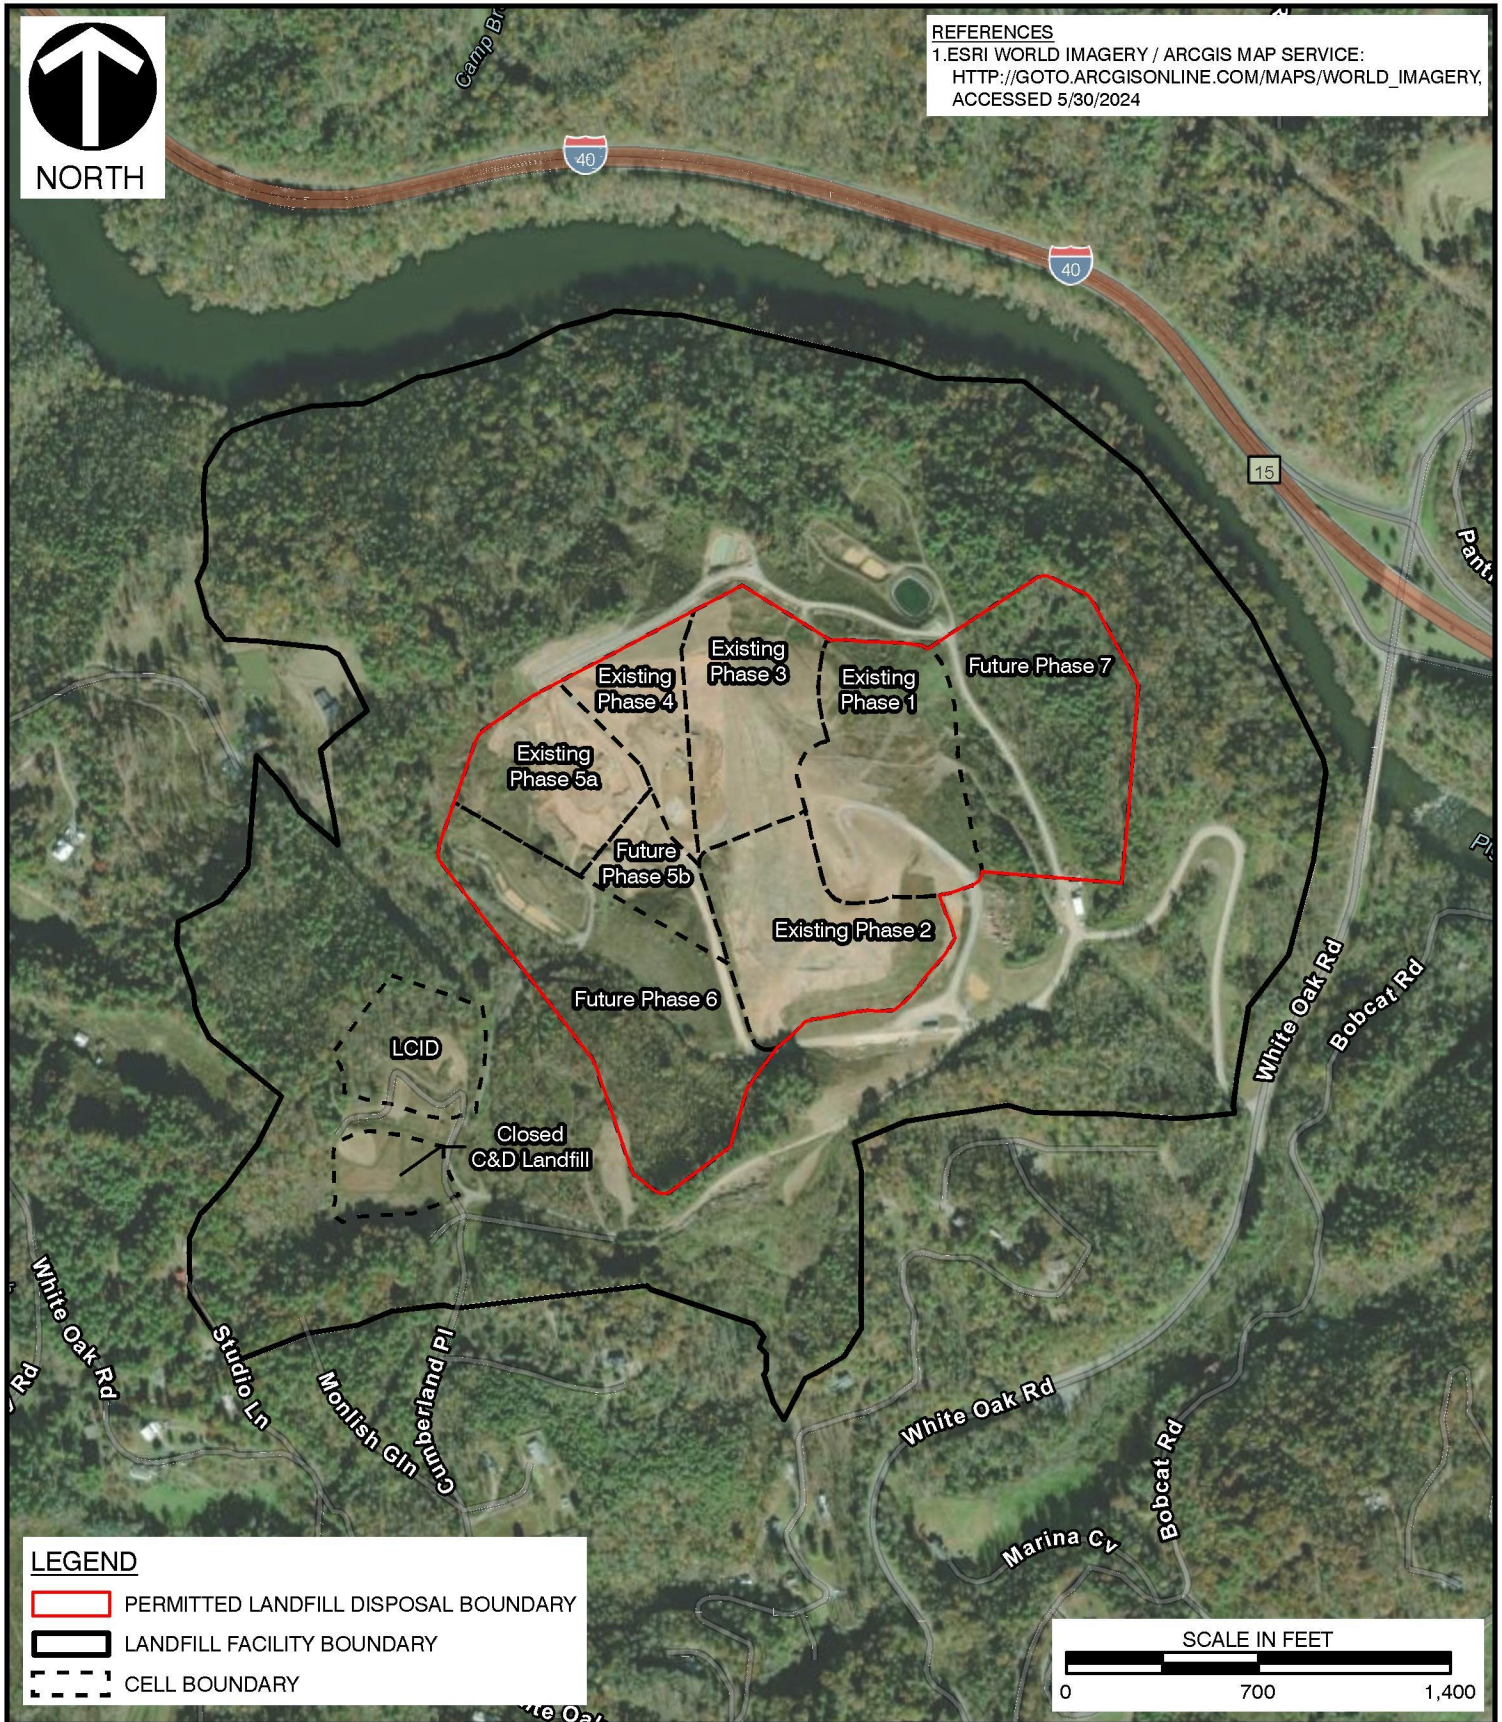

LEGEND

- PERMITTED LANDFILL DISPOSAL BOUNDARY
- LANDFILL FACILITY BOUNDARY
- CELL BOUNDARY

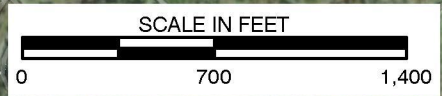

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REPUBLIC SERVICES, INC.
 WHITE OAK LANDFILL
 HAYWOOD COUNTY, NORTH CAROLINA

CURRENT SITE PLAN


DRAWN BY:	NTP	CHECKED BY:	LRM	APPROVED BY:	LRM*	FIGURE NO:	2
DATE:	5/29/2024	SCALE:	1"=700'	PROJECT NO:	331-924		

*Hand Signature on file

P:\330-000\331-924\GIS\Maps\EC01_White_Oak_Landfill.aprx 5/29/2024 2:17 PM (npamukocglu)



REFERENCES
 1. ESRI WORLD IMAGERY / ARCGIS MAP SERVICE:
 HTTP://GOTO.ARCGISONLINE.COM/MAPS/WORLD_IMAGERY,
 ACCESSED 6/13/2024
 2. CONTOURS DERIVED FROM NC ONE MAP WEBSITE:
 WWW.NCONEMAP.GOV

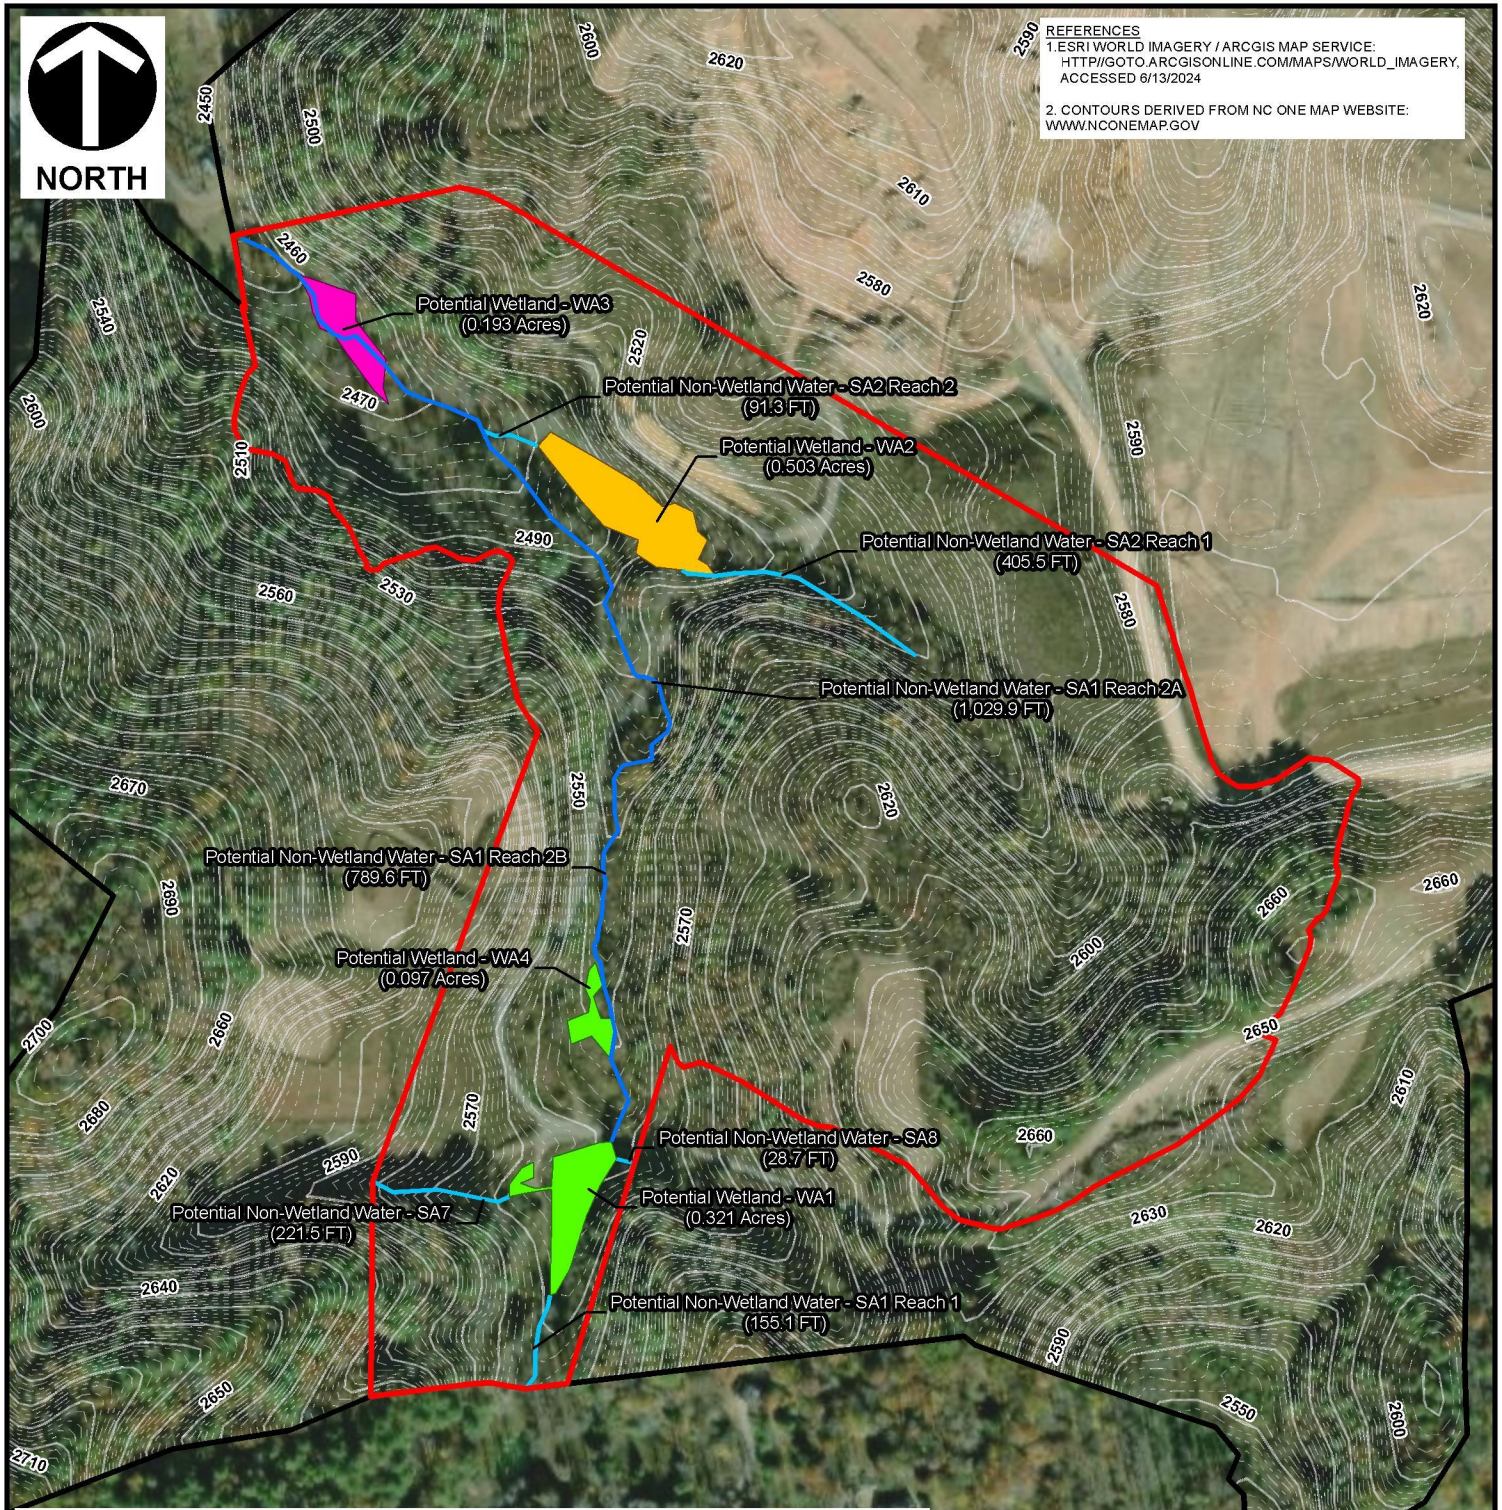

LEGEND	
	LANDFILL FACILITY BOUNDARY (269.3 ACRES)
	PROJECT REVIEW AREA (39.6 ACRES)
	PEM WETLAND
	PFO WETLAND
	PSS WETLAND
	PERENNIAL STREAM
	INTERMITTENT STREAM
	2. FT INTERMEDIATE CONTOURS
	10 FT. INDEX CONTOURS
	PROJECT REVIEW AREA (39.6 ACRES)



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 www.cecinc.com

REPUBLIC SERVICES, INC.
 WHITE OAK LANDFILL
 HAYWOOD COUNTY, NORTH CAROLINA

POTENTIAL WATERS OF THE U.S. MAP

DRAWN BY:	ZAF	CHECKED BY:	LRM	APPROVED BY:	LRM	FIGURE NO:	3
DATE:	6/13/2024	SCALE:	1"=300'	PROJECT NO:	331-924		

*Hand Signature on file

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NOTES

1. THE PROPOSED AND EXISTING MONITORING LOCATIONS SHOWN HEREON ARE SUBJECT TO THE PERMITS AND REGULATIONS OF THE NORTH CAROLINA DEPARTMENT OF ENVIRONMENT AND NATURAL RESOURCES. THIS PROJECT IS NOT CERTIFIED AS COMPLIANT BY THIS ENGINEER, UNLESS IT IS THIS DATE AND SUBJECT TO THE PERMITS AND REGULATIONS OF THE NORTH CAROLINA DEPARTMENT OF ENVIRONMENT AND NATURAL RESOURCES.
2. PROPERTY LINE DATA WAS OBTAINED FROM THE PHASE 6B PERMIT TO CONSTRUCT (P6B) AND THE PHASE 6A PERMIT TO CONSTRUCT (P6A) AND THE ENVIRONMENTAL CONSULTANTS, INC. (ECON) ADDITIONAL REPORT DATED AUGUST 31, 2022.
3. THIS PLAN IS THE PROPERTY OF ECON AND IS NOT TO BE REPRODUCED OR COPIED IN ANY MANNER WITHOUT THE WRITTEN PERMISSION OF ECON.

MONITORING LOCATION LEGEND

- SURVEYED LOCATION OF PNEZOMETER OR BOPING
- SURVEYED LOCATION OF GROUNDWATER MONITORING WELL
- ▲ SURVEYED LOCATION OF METHANE MONITORING PROBE
- APPROXIMATE LOCATION OF SURFACE WATER MONITORING POINT
- APPROXIMATE LOCATION OF UNDERGROUND MONITORING POINT
- PROPOSED LOCATION OF GROUNDWATER MONITORING WELL
- PROPOSED LOCATION OF SURFACE WATER MONITORING POINT
- ▲ PROPOSED LOCATION OF METHANE MONITORING PROBE




EXISTING TOPOGRAPHIC CONDITIONS

ENGINEERING PLANS
PHASE 6 PERMIT TO CONSTRUCT
HAYWOOD COUNTY (WHITE OAK) LANDFILL
SANTEK ENVIRONMENTAL OF NORTH CAROLINA, LLC
HAYWOOD COUNTY BOARD OF COMMISSIONERS
66 Republic Services, Inc. (2023)

HHTT
 HODGES, HARRIS, NEWBERRY & TRIBBLE, INC.
 Consulting Engineers
 3903 ASHTONBRIAR RD.
 NC, CARRBORO, NC 27513-1011
 MACKIN, RICHARDSON & CO. ENGINEERS
 6703 S. 1132 EAST HWY 100
 RENO, NV 89502
 SCALE: 1" = 300'
 DATE: JUNE 2024

SHEET 3 OF 20

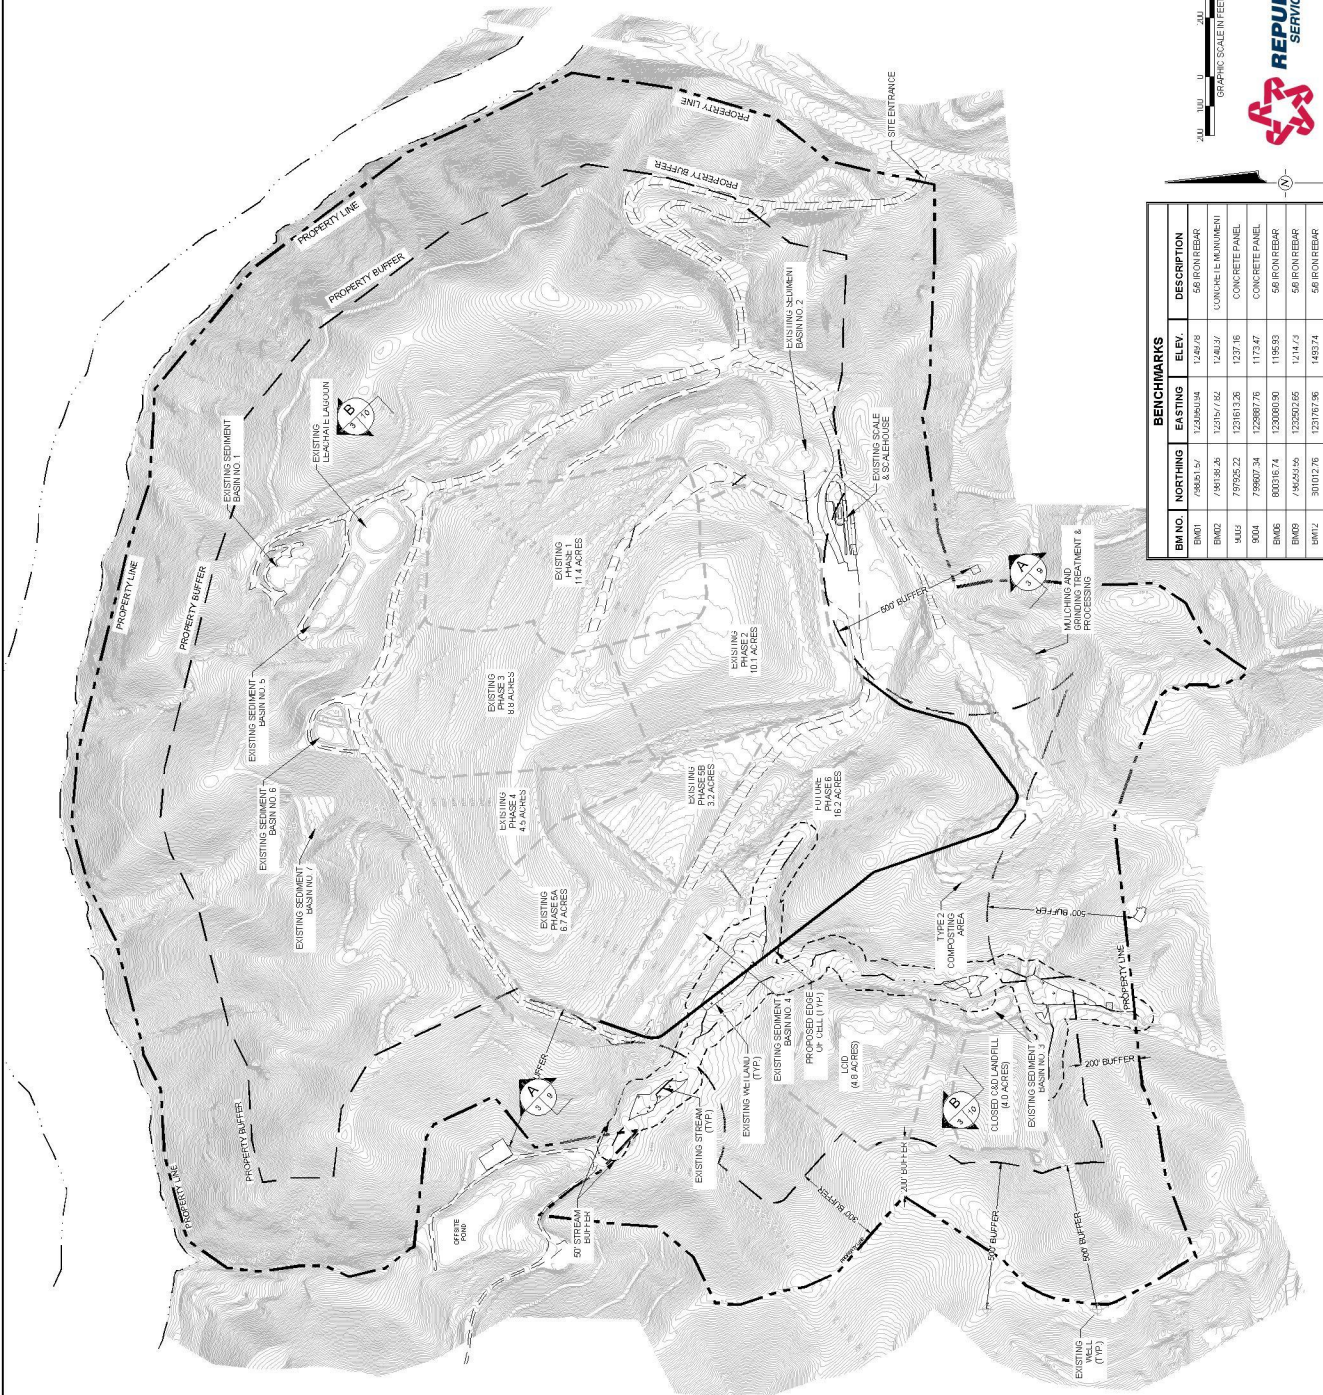

BENCHMARKS			
B.M. NO.	NORTHING	EASTING	ELEV. DESCRIPTION
BM01	74853.57	123393.04	1248.76 56 ROR REBAR
BM02	749138.28	123215.782	1240.37 CONCRETE MONUMENT
M05	799255.22	1231613.36	1237.16 CONCRETE PANEL
9004	799207.34	122987.76	1173.47 CONCRETE PANEL
BM06	808181.74	1231000.90	1195.93 56 ROR REBAR
BM08	746254.56	1232032.62	1241.73 56 ROR REBAR
BM12	301012.76	123197.96	1493.74 56 ROR REBAR

20 0 20 40 60 80 100 120 140 160 180 200
 GRAPHIC SCALE IN FEET


DRAINAGE STRUCTURES

Pipe No.	Size	Length	Slope	Material
400	36"	213'	14.83%	RCP
401	36"	134'	14.83%	RCP
600	36"	145'	31.03%	RCP
801	36"	122'	13.11%	RCP
ST-1	24"	123'	28.1%	RCP
ST-2	48"	89'	6.74%	RCP
SI-3	30"	100'	8.13%	RCP

UNSWAPABLE PILE	TOP	FINISH	INVERT
400	1322.00	1320.00	1210.00
600	1427.00	1425.00	1365.00


THROAT	TOP	THROAT	INVERT
401	1216.00	1214.00	1210.00
801	1340.00	1340.00	1340.00

HEADWALL NO	INVERT	HEADWALL NO	INVERT
400	1210.00	SE	1278.00
401	1190.00	SS	1240.00
800	1340.00	SA	1194.00
601	1324.00	SS	1216.00
SI	1310.00	SA	1349.00

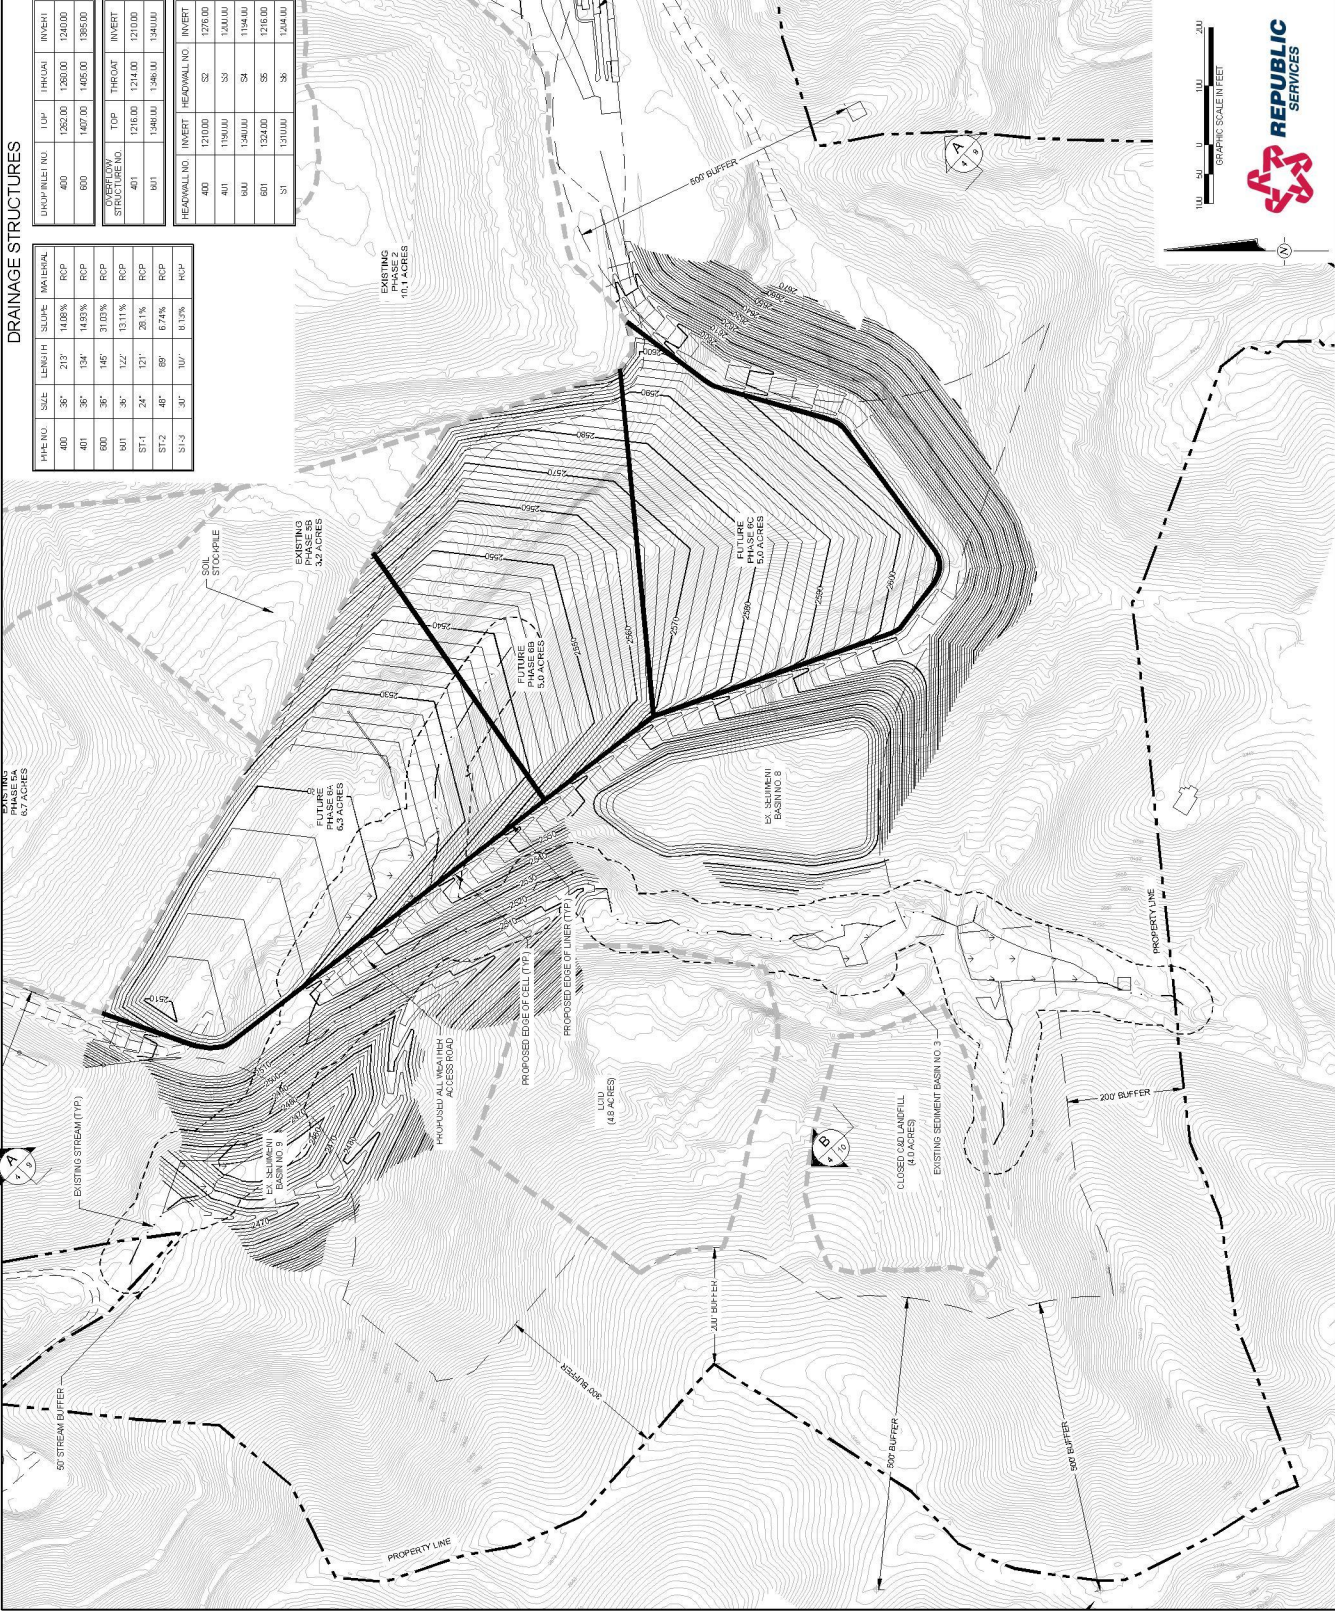

NOTES

- THE TOPOGRAPHIC AND ELEVATION DATA SHOWN HEREON WAS OBTAINED FROM GPS SURVEY DATA DATED APRIL 12, 2017 AND IS NOT CERTIFIED AS CORRECT BY THIS ENGINEER. USERS OF THIS DATA DO SO AT THEIR OWN RISK.
- PROPERTY LINE DATA WAS OBTAINED FROM THE PHASE 4B PERMIT TO CONSTRUCT, DATED JANUARY AND REVISIONED BY SANKET & MOORE.
- STREAM AND WETLAND INFORMATION PROVIDED BY CIVIL AND ENVIRONMENTAL CONSULTANTS, INC., JURISDICTIONAL REPORT DATED AUGUST 31, 2022.
- EXISTING STORM DRAIN PIPE INFORMATION WAS TAKEN FROM THE ENGINEERING PLANS - PHASE NO. 4, DATED JANUARY 2014, PREPARED BY HODGES, HARRIN, NEWBERRY & TRIBBLE, INC.
- STREAMS NEAR THE WESTERN PROPERTY BOUNDARY WERE DEMARCATED AND DELETED FROM THE SURVEY DATA. THE PROPERTY BOUNDARY WAS RECONSTRUCTED BY ENGINEERS ISSUED A NOTIFICATION OF JURISDICTIONAL DETERMINATION FOR THESE STREAMS ON OCTOBER 10, 2020. SURVEYS OF THE PROPERTY BOUNDARY WERE CONDUCTED BY SANKET & MOORE, HARRIN, NEWBERRY & TRIBBLE, INC. IN AUGUST 2022.
- STREAMS, WETLANDS AND DWARF FLOWERS HEARTLEAF AREAS WERE DEMARCATED BY DIFFERENTIATED HATCH. FILED IN AUGUST 2019. THESE AREAS WERE INVESTIGATED FOR THE POTENTIAL BORDERS AS FORTHILLS. WETLAND BOUNDARIES, DEGRADED STREAMS AND METLANDS WERE PERFORMED BY WRIGHT AND HELMS LAND SURVEYING IN JULY 2019.
- BASE GRADES IN CELLS NO. 6, 7, AND 8B REPRESENT TOP OF FLEXIBLE MEMBRANE LINER.
- BASED ON THE REPORT OF SUBGRADE SETTLEMENT AND SLOPE STABILITY ANALYSIS BY HARRIN, NEWBERRY & TRIBBLE, INC., THE HIGHLIGHTED STRUCTURAL FILL SLOPES OF 2:1 V:1 H:1 WILL BE BRIDGED BY EXCAVATING RESIDUAL SOILS AND REPLACING WITH 2.5H:1 V:1 SLOPES OF COMPACTED FILL OVER THE LOWER PORTION OF SLOPE. THE EXISTING SLOPE WILL BE MAINTAINED WHERE SLOPES ARE 2:1 V:1. SLOPE COULD BE CONDUCTED OR FILL MEMBERS OF SELECTED ROCK FILL MATERIAL MAY BE USED IN ADDITION TO INSTALLATION OF A TIRE DRUM OPTION TO IMPROVE LONG TERM SLOPE STABILITY.
- ALL ACTIVITIES ASSOCIATED WITH STREAM CROSSINGS NO. 1 AND 2 SHALL BE IN ACCORDANCE WITH THE CONDITIONS OF THE DEPARTMENT OF ENVIRONMENTAL MONITORING SYSTEM PROVIDED BY PERMIT DWR AND 19B NO. SWW-2002-111 AND NORTH CAROLINA PERMIT DWR AND 19B NO. SWW-2002-111 AND NORTH CAROLINA PERMIT DWR AND 19B NO. SWW-2002-111 AND NORTH CAROLINA PERMIT DWR AND 19B NO. SWW-2002-111.
- MONITORING LOCATIONS TAKEN FROM DRAWINGS TITLED "ENVIRONMENTAL MONITORING SYSTEM PROVIDED BY PERMIT DWR AND 19B NO. SWW-2002-111 AND NORTH CAROLINA PERMIT DWR AND 19B NO. SWW-2002-111 AND NORTH CAROLINA PERMIT DWR AND 19B NO. SWW-2002-111".
- ENVIRONMENTAL MONITORING SYSTEM PROVIDED BY PERMIT DWR AND 19B NO. SWW-2002-111 AND NORTH CAROLINA PERMIT DWR AND 19B NO. SWW-2002-111 AND NORTH CAROLINA PERMIT DWR AND 19B NO. SWW-2002-111.
- ENVIRONMENTAL MONITORING SYSTEM PROVIDED BY PERMIT DWR AND 19B NO. SWW-2002-111 AND NORTH CAROLINA PERMIT DWR AND 19B NO. SWW-2002-111 AND NORTH CAROLINA PERMIT DWR AND 19B NO. SWW-2002-111.
- ENVIRONMENTAL MONITORING SYSTEM PROVIDED BY PERMIT DWR AND 19B NO. SWW-2002-111 AND NORTH CAROLINA PERMIT DWR AND 19B NO. SWW-2002-111 AND NORTH CAROLINA PERMIT DWR AND 19B NO. SWW-2002-111.

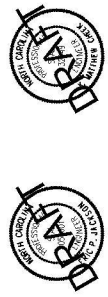

TOP OF SOIL GRADING PLAN

**ENGINEERING PLANS
PHASE 6 PERMIT TO CONSTRUCT
HAYWOOD COUNTY (WHITE OAK) LANDFILL
SANKET ENVIRONMENTAL OF NORTH CAROLINA, LLC
AND
HAYWOOD COUNTY BOARD OF COMMISSIONERS**

HHTT
HODGES, HARRIN,
NEWBERRY & TRIBBLE, INC.
Consulting Engineers
NO. 3000 FARM ROAD, SUITE 100
MAYNOR, NORTH CAROLINA 27560
6703-1132 (PH) 6703-1133 (FAX) 6703-1133 (CELL) 6703-1133 (TEXT) 6703-2024 (EMAIL)

PROJECT NO. 6703-1132 (PH) 6703-1133 (FAX) 6703-1133 (CELL) 6703-1133 (TEXT) 6703-2024 (EMAIL)

SCALE 1" = 100'

DATE JUNE 2024

SHEET 4 OF 20

REPUBLIC SERVICES